



## YANNACCONE VILLA & ALDRICH, LLC

460 MAIN STREET, P.O. BOX 459 CHESTER, NEW JERSEY 07930 PHONE: 908-879-6646 FAX: 908-879-8591 N.J. STATE BOARD FOR P.E. & P.L.S. CERTIFICATE OF AUTHORIZATION No. 24GA27934500

NEW JERSEY LICENSED PROFESSIONAL ENGINEER AND LAND SURVEYOR No. 42575 NOT VALID WITHOUT SIGNATURE AND RAISED SEAL REV. PER TWP. REVIEW 1 3/4/24 NO. DATE REVISION PROJECT TITLE :

## 15 VILLAGE ROAD LLC PROJECT

15 VILLAGE ROAD LOT 5 ~ BLOCK 18 TOWNSHIP OF HARDING MORRIS COUNTY, NEW JERSEY

SHEET TITLE :
EXISTING
CONDITIONS &
TREE REMOVAL
<u>PLAN</u>

	<b>√√/ ∀</b>
DRAWN BY:	DATE:
JAWARL 5	11/9/23
CHECKED BY:	SCALE:
RL5	1" = 30'
W.O.	
F.B.	

COMP FILE:
M:SEPTIC/.../220159/BOASitePlan\_rev1.dwg

SHEET  $m{2}$  OF  $m{9}$ 

ORDINANCE ITEM	REQUIRED/ALLOWED	PROPOSED/EXISTING
MIN. LOT AREA	9,000 SQ. FT.	17,894 SF (1)
		48,644 SF (2)
MIN. FRONT YARD	20 FT.	10.4 FT. (3)
MIN. LOT WIDTH	65 FT.	115.3 FT.
MIN. SIDE YARD	6 FT.	N.A., NO SIDEYARDS PRESENT
MIN. SIDE YARD COMBINED	23.06 FT. 20% OF LOT WIDTH	N.A., NO SIDEYARDS PRESENT
MIN. REAR YARD	15 FT. OR MIN. OF 10% OF LOT DEPTH, WHICHEVER IS GREATER	4.7 FT. (TO EXIST. BLDG.) (3) UNIT#1-BLDG10.2 FT.(9) UNIT#1-PATIO -10.3 FT.(9)
	157.14 FT.(.10)=15.7 FT. (8)	
MIN. LOT FRONTAGE	65 FT.	118.4 FT. (AT R.O.W. LINE)
MAX. FLOOR AREA	20%/3,579 SF(1),(4)	19.5 %/3,485 SF(6)
MAX. BUILDING AREA (7)	15%/2,684 SF(1)	9.3% (1,673 SQ. FT.)(EXISTING) 12.3% (2,193 SQ. FT.)(WITH NEW BLDG. & WITHOUT DETACHED GARAGE)
MAX. LOT COVERAGE	50%/8,947 SF(1)	38.2% (6,831 SQ. FT.)(EXISTING) 49.1% (8,778 SQ. FT.)
MAX. BUILDING HEIGHT	35 FT.	<35 FT.
USE	MIXED(OFFICE/RESIDENTIAL)	MIXED(OFFICE/RESIDENTIAL COTTAGE)
		SEPTIC WITHIN R-3 ZONE AREA (9)

**ZONE REQUIREMENTS** 

- (1) AREA WITHIN B-1 ZONE
- (2) OVERALL LOT AREA (WITHIN B-1 AND R-3 ZONES)
- (3) EXISTING, NON—CONFORMING CONDITION.
- (4) 20% IS ACCEPTABLE BECAUSE THE PROPERTY IS IN THE NEW VERNON HISTORIC DISTRICT, THE EXISTING STRUCTURE
  IS BEING RETAINED AND IS A CONTRIBUTING STRUCTURE TO THE HISTORIC CHARACTER OF THE DISTRICT.
- (5) THE VALUES PROVIDED UNDER PROPOSED/EXISTING CONDITIONS ARE FOR THE PORTION OF THE PROPERTY
  WITHIN THE B-1 ZONE ONLY. SEE ZONING TABLE AT RIGHT FOR PORTION OF PROJECT IN THE R-3 ZONE.
- (6) FLOOR AREA VALUE FOR OFFICE BUILDING IS 1,751 SQ. FT AND WAS PROVIDED BY BYRNE DESIGN ASSOCIATES.

  NOT INCLUDED IN THE EXISTING FLOOR AREA IS THE OPEN FRONT PORCH (245 SQ. FT.).

  FLOOR AREA VALUE FOR THE PROPOSED RESIDENCE IS 1,734 SQ. FT AND WAS PROVIDED BY BYRNE DESIGN ASSOCIATES
- FLOOR AREA VALUE FOR THE PROPOSED RESIDENCE IS 1,734 SQ. FT AND WAS PROVIDED BY BYRNE DESIGN ASSOCIATES.
  THIS VALUE INCLUDES 170 SQ. FT. OF ATTIC SPACE.

  (7) PROPOSED BUILDING AREA EXCLUDES THE COVERED FRONT PORCH FOR THE PROPOSED RESIDENCE. THE FRONT
- PORCH FOR THE RESIDENCE IS OPEN AND EXTENDS NO MORE THAN 4 FT. FROM THE STRUCTURE.

  (8) LOT DEPTH VALUE OF 157.14 FT. SHOWN HAS BEEN MEASURED FROM THE MIDPOINT OF ROAD RIGHT OF WAY ALONG
- (8) LOT DEPTH VALUE OF 157.14 FT. SHOWN HAS BEEN MEASURED FROM THE MID VILLAGE ROAD TO THE MIDPOINT OF LOT AT THE B-1/R-3 ZONE BOUNDARY.
- (9) PROPOSED VARIANCE CONDITION

#### ZONE REQUIREMENTS

FOR PORTION OF PROPERTY LOCATED IN THE R-3 ZONE - RESIDENTIAL

ORDINANCE ITEM	REQUIRED/ALLOWED	PROPOSED
MIN. LOT AREA	15,000 SQ. FT.	30,750 SF (1) 48,644 SF (1)
MIN. FRONT YARD	35 FT.	77.3 FT.(UNIT #2)/ 91.8 FT. (UNIT#3/4) (2) 69.5 FT.(DECK-UNIT #2), 89.5 FT.(PATIO-UNIT #3/4) (10) 81.1 FT.(STEPS-UNIT #3/#4), STEPS (10)
MIN. LOT WIDTH	85 FT.	166.4 FT. (3)
MIN. SIDE YARD	10 FT.	N.A., NO SIDEYARDS PRESENT
MIN. SIDE YARD COMBINED	20% OF LOT WIDTH .2(166.4 FT.) = 33.28 FT.	N.A., NO SIDEYARDS PRESENT
MIN. REAR YARD	25 FT. OR MIN. OF 25% OF LOT DEPTH, WHICHEVER IS GREATER .25(186.65 FT) = 46.66 FT. (6)	UNIT#2-BLDG13.5 FT.(9) UNIT#3,4-BLDG16.1 FT (9) UNIT#2-PATIO -21.5 FT.(9) UNIT#3,4-DECKS-10.2 FT, 37.5 FT(5) UNIT#2-GEN15.7 FT.(9) UNIT#3,4-GENS-15.7 FT, 27.1 FT (5) UNIT#2-AC-20.2 FT.(9) UNIT#3,4-ACS-20.0 FT, 30.4 FT (9)
MIN. LOT FRONTAGE	85 FT.	187.34 FT. (AT MILLBROOK R.O.W. LINE)
MIN. FLOOR AREA	750 SF AT FIRST FLOOR EXCLUSIVE OF PORCHES/GARAGES	750 SF. MINIMUM(AT FIRST FLOOR) SEE ARCHITECT'S PLAN FOR ADDITIONAL DETAIL
MAX. BUILDING AREA (8)	2,500 SF (7) (8)	2,488 SF (8)
MAX. LOT COVERAGE	N/A	N/A
MAX. BUILDING HEIGHT	35 FT.	<35 FT.
USE	SINGLE FAMILY	1 SINGLE FAMILY COTTAGE/1—2 FAMILY TOWNHOUSE 3 UNITS PROPOSED (9)

- (1) AREA WITHIN R-3 ZONE = 30,750 SF, OVERALL LOT AREA = 48,644 SF
- (2) FRONT YARD IS INTERPRETED AS BEING MEASURED FROM MILLBROOK ROAD. VALUES PROVIDED ARE TO THE CLOSEST PORTIONS OF THE TWO RESIDENTAL STRUCTURES (UNITS #2 & #3/#4) TO MILLBROOK ROAD. SEE PLAN VIEW FOR SPECIFIC DIMENSIONS TO EACH RESPECTIVE COMPONENT OF DWELLING AND NEARBY UTILITY PADS.
- (3) LOT WIDTH WAS MEASURED FACING MILLBROOK ROAD
- (4) FIRST VALUE PROVIDED IS THE DIMENSION FROM THE MOST NORTHERLY STRUCTURE TO ITS CLOSET SIDELINE(16.1 FT.)

  SECOND VALUE PROVIDED IS THE DIMENSION FROM THE MOST SOUTHERLY STRUCTURE TO ITS CLOSET SIDELINE(13.5 FT.)

  NOTE: DECK ON MOST NORTHERLY RESIDENCE IS SHOWN AS 10.2 FT FROM THE SIDELINE.
- (5) FIRST VALUE PROVIDED IS THE DIMENSION OF THE MOST NORTHERLY STRUCTURE TO ITS COMBINED SIDELINES. SECOND VALUE PROVIDED IS THE DIMENSION OF THE MOST SOUTHERLY STRUCTURE TO ITS COMBINED SIDELINES.
- (6) LOT DEPTH VALUE OF 186.65 FT. SHOWN HAS BEEN MEASURED FROM THE MIDPOINT OF ROAD RIGHT OF WAY ALONG MILLBROOK ROAD TO THE CLOSEST PROPERTY CORNER ALONG THE BOUNDARY LABELED "N 35 56 00", 60.00 FT.
- (7) BUILDING AREA IS BASED ON THE LESSER OF 6 PERCENT OF OVERALL LOT AREA (WITHIN BOTH B-1 AND R-3 ZONES)
  AND A SQUARE FOOTAGE OF 2,500 SQUARE FEET FOR A LOT THAT HAS AN AREA BETWEEN 37,501 SF & 87,120 SF.
- AND A SQUARE FOOTAGE OF 2,500 SQUARE FEET FOR A LOT THAT HAS AN AREA BETWEEN 37,501 SF & 87,120 SF.
  WITH THE CURRENT CONCEPT THE 2,500 SF VALUE CONTROLS SINCE .6(48,644 SF) = 2,918.6 SF.
- (8) PROPOSED BUILDING AREA EXCLUDES THE COVERED FRONT PORCHES OF THE PROPOSED RESIDENCES. THE FRONT PORCHES ARE OPEN AND EXTEND NO MORE THAN 4 FT. FROM THE STRUCTURES.

  (9) PROPOSED VARIANCE CONDITION
- (10) PROPOSED VARIANCE CONDITION, PROPOSED DECK/PATIO/STEPS CLOSER TO ROAD RIGHT OF WAY THAN FRONT FACADE OF BLDG.

10T 302

OFF-STREET PARKING REQUIREMENT:

OFFICE SPACE = 1,751 SQ.FT.

BARRIER FREE DESIGN:THE LAW, NEW JERSEY

ACCESSIBLE PARKING REQUIREMENT:

OFFICE USE: 1 SPACE/250 SF

HARDING TOWNSHIP ORDINANCE SECTION 225-147.B

1,751 SQ.FT. x 1 SPACE/250 SQ.FT. = 7.0 ~ 7 SPACES REQUIRED

5 OFFICE SPACES (10' x 20') & 2 OFFICE SPACES (10' x 19') ARE PROVIDED

SECTION 5:23-7.9 (c.) 7 PARKING SPACES REQUIRES 1 ACCESSIBLE PARKING SPACE

PROPOSED ONE (1) ACCESSIBLE PARKING SPACE SHALL BE VAN-ACCESSIBLE.

NOTE: FOR EVERY EIGHT ACCESSIBLE PARKING SPACES, OR FRACTION THEREOF, AT LEAST ONE SHALL BE A VAN ACCESSIBLE PARKING SPACE.

TOTAL OVERALL LOT COVERAGE

FOR ENTIRE PROJECT

6.831 SF(EXISTING) + 8,482 SF(NET CHANGE) = 15,313 SF

#### N 54°05'20" E 247.95' FOUND I.PIPI 5' TREE CONSERVATION AREA LOT 4 DETACHED GARAGE 41.1' , 46.66' REAR YARD SETBACK N 52°52'00" E 193.00' CL 10.0' 66 15.7' REARYARD SETBACK 186.65' Ó PROPOSED N SECTIONS OF *ACCESS* 1 EXISTING PARKING TO BE REMOVED 00 DRIVE 46.66' REAR YARD SETBACK GRAVEL POTENTIAL 3 BEDR. RESIDENTAL POTENTIAL 2 BEDR. 8.95 RESIDENTAL UNIT #. G. 15.7' REARYARD SETBACK ON SLAB NO BASEMENT TFF- 346.5 NO BASEMENT FF- 350.5 FOUND I.PIPE 4.7 5' TREE CONSERVATION AREA CURB ASPHALT PARKING LOT EXIST. WELL S 51°39'20" W ₹ C 323.80' CL NET CHANGE IN OVERALL LOT COVERAGE (323.42' DEED) FOR ENTIRE PROJECT LOT COVERAGE ADDED IN B-1 ZONE + R-3 ZONE - LOT COVERAGE R R TO BE REMOVED IN B-1 ZONE = GRAPHIC SCALE LOT 6 3.744 SF + 6,515 SF - 1,777 SF = 8,482 SF

( IN FEET )

1 inch = 20 ft.

## FOR PORTION OF PROPERTY LOCATED IN THE B-1 ZONE HISTORIC VILLAGE BUSINESS ZONE

EXISTING LOT COV	/ERAGE
	AREA (SQ. FT.)
OFFICE BUILDING	1,051
PORCH	250
DETACHED GARAGE	372
DRIVEWAY/PARKING LOT	4,999
WALKS/STAIRS/STOOPS	126
PADS	33
TOTAL (SQ. FT.)	6,831

EXISTING BUILDING COVERAGE	
	AREA (SQ. FT.)
OFFICE BUILDING	1,051
PORCH	250
DETACHED GARAGE	372
TOTAL (SQ. FT.)	1,673

EXISTING LOT COVERAGE TO BE REMOVED	
	AREA (SQ. FT.)
PORTIONS OF WALKS/DRIVEWAY	1,405
DETACHED GARAGE	372
TOTAL (SQ. FT.)	1,777

PROPOSED LOT COVERAGE TO BE ADDED (1)	
	AREA (SQ. FT.)
RESIDENTIAL BUILDING	988 (1)
PORTIONS OF NEW DRIVEWAY AREA	2,351
PORTIONS OF WALKS/PATIO	245
AC/GENERATOR/TRASH PADS	160
TOTAL (SQ. FT.)	3,744 (1)

#### (1) PROPOSED LOT COVERAGE AREA INCLUDES THE COVERED FRONT ENTRY OF THE PROPOSED RESIDENCE.

PROPOSED BUILDING COVERAGE (2)	
	AREA (SQ. FT.)
OFFICE BUILDING	1,051
PORCH	250
RESIDENTAL BUILDING #1	892 (2)
TOTAL (SQ. FT.)	2,193 (2)

(2) PROPOSED BUILDING AREA EXCLUDES THE COVERED FRONT ENTRY OF THE PROPOSED RESIDENCE. THE FRONT ENTRY IS OPEN AND EXTENDS NO MORE THAN 4 FT. FROM THE STRUCTURE.

## FOR PORTION OF PROPERTY LOCATED IN THE R-3 ZONE RESIDENTIAL

PROPOSED LOT COVERAGE TO	BE ADDED (3)
	AREA (SQ. FT.)
RESIDENTAL BUILDINGS #2 & #3/#4	2,709(3)
PORTIONS OF DRIVEWAY/CUL-DE-SAC AREA	3,128
WALKS/PATIOS/DECKS	582
AC/GENERATOR PADS	96
TOTAL (SQ. FT.)	6,515 (3)

(3) PROPOSED LOT COVERAGE AREA INCLUDES THE COVERED FRONT ENTRY OF THE PROPOSED RESIDENCES

PROPOSED BUILDING COV	/ERAGE (4)
	AREA (SQ. FT.)
RESIDENTAL BUILDINGS #2 & #3/#4	2,488 (4)
\	CONT CATELY OF THE DECRA

(4) PROPOSED BUILDING AREA EXCLUDES THE COVERED FRONT ENTRY OF THE PROPOSED RESIDENCES. THE FRONT ENTRY IS OPEN AND EXTENDS NO MORE THAN 4 FT. FROM THE STRUCTURE.

\ <b>V</b> / \
Civil Engineers & Land Surveyors
YANNACCONE VILLA & ALDRICH, LLC

460 MAIN STREET, P.O. BOX 459
CHESTER, NEW JERSEY 07930
PHONE: 908-879-6646
FAX: 908-879-8591

N.J. STATE BOARD FOR P.E. & P.L.S. CERTIFICATE
OF AUTHORIZATION No. 24GA27934500

RYAN L. SMITH DATE:

NEW JERSEY LICENSED PROFESSIONAL ENGINEER AND LAND SURVEYOR No. 42575

NOT VALID WITHOUT SIGNATURE AND RAISED SEAL

1 3/4/24 ADD EXISTING SIGN

10. DATE REVISION

PROJECT TITLE:

15 VILLAGE ROAD

LLC PROJECT

15 VILLAGE ROAD

LOT 5 ~ BLOCK 18

TOWNSHIP OF HARDING

MORRIS COUNTY, NEW JERSEY

SHEET TITLE :

ZONING
PLAN

FILE:

COMP FILE:

M:SEPTIC/.../220159/BOASitePlan\_rev1.dwg

SHEET  $oldsymbol{3}$  of  $oldsymbol{9}$ 

#### GENERAL NOTES: 1. LOT BOUNDARY AND TOPOGRAPHIC SURVEY AS SHOWN WERE TAKEN FROM A SURVEY PREPARED BY THIS FIRM, CHRISTOPHER J. ALDRICH, NJLS #34478, DATED 1/6/21, VERTICAL DATUM: NAVD 88. 2. THE NET INCREASE IN OVERALL LOT COVERAGE FOR THIS PROJECT IS 8,462 SQ. FT. THE OVERALL AMOUNT OF SOIL DISTURBANCE FOR THIS PROJECT IS 39,914 SQ. FT. 3. THERE ARE NO WETLANDS WITHIN 150 FEET OF THE PROPOSED SOIL SOIL DISTURBANCE SHOWN ON THESE PLANS. SEE REPORT BY ENVIRONMENTAL TECHNOLOGY FOR CROSS REFERENCING. 4. THERE ARE NO CATEGORY ONE WATERS WITHIN 300 FEET OF THE PROPOSED SOIL SOIL DISTURBANCE SHOWN ON THESE PLANS. SEE REPORT BY ENVIRONMENTAL TECHNOLOGY FOR CROSS REFERENCING. 5. THE PROPOSED DEVELOPMENT SHALL BE SERVED BY AN INDIVIDUAL POTABLE WATER WELL, AN INDIVIDUAL SEPTIC DISPOSAL SYSTEM AND PUBLIC GAS. 6. THE PROPOSED BUILDING PLANS WERE PREPARED BY BYRNE DESIGN ASSOCIATES, WILLIAM BYRNE, RA. SEE THEIR PLAN FOR CROSS REFERENCING. 7. THERE ARE NO PROPOSED STREET LIGHTS PROPOSED WITH THE CURRENT PROJECT. 8. EXISTING UNDERGROUND UTILITY INFORMATION SHOWN HEREON IS APPROXIMATE AND IS NOT GUARANTEED AS TO ACCURACY OR COMPLETENESS. THE CONTRACTOR SHALL VERIFY ALL INFORMATION PRIOR TO BEGINNING ANY CONSTRUCTION. THE CONTRACTOR SHALL CONTACT ONE CALL SERVICE AT 1-800-272-1000 AND OTHER LOCAL UTILITY COMPANIES AS REQUIRED FOR MARKOUT PRIOR TO ANY EXCAVATION. WHERE EXISTING UNDERGROUND UTILITIES ARE TO BE CROSSED BY PROPOSED CONSTRUCTION, TEST PITS SHALL BE DUG BY THE CONTRACTOR PRIOR TO CONSTRUCTION TO ASCERTAL EXISTING LOCATIONS, ELEVATIONS, MATERIALS AND SIZES. TEST PIT INFORMATION SHALL BE GIVEN TO THE ENGINEER PRIOR TO CONSTRUCTION TO PERMIT ADJUSTMENTS AS REQUIRED TO AVOID CONFLICTS. 9. THIS SET OF PLANS HAS BEEN PREPARED FOR THE PURPOSES OF SITE PLAN REVIEW AND APPROVAL BY THE HARDING TOWNSHIP PLANNING BOARD, HARDING TOWNSHIP BOARD OF HEALTH AND MORRIS COUNTY PLANNING BOARD. THESE PLANS SHALL NOT BE UTILIZED AS CONSTRUCTION PLANS UNTIL ALL APPLICABLE APPROVALS HAVE BEEN GRANTED FOR THIS PROJECT. 10. THE EXISTING DRYWELL & SEPTIC SHALL BE CRUSHED IN PLACE AND BACKFILLED W/ COMPACTED SILTY CLAY, CLAY SOIL, FREE OF DEBRIS AND OR STONES. BOARD OF HEALTH TO WITNESS ABANDONMENT. 11. A ROAD OPENING PERMIT IS REQUIRED FOR CONSTRUCTION OF UTILITY CONNECTIONS FROM VILLAGE ROAD TO NEW STRUCTURES (I.E., GAS, ELECTRIC, CABLE). 12. ALL ON SITE GRADING NOT TO EXCEED 3:1 SLOPES.

SECTIONS OF

EXISTING PARKING TO BE REMOVED

CURB

EXIST. WELL

ASPHALT PARKING LOT

4267/176 & THIS SURVEY

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GRAVEL

18.95


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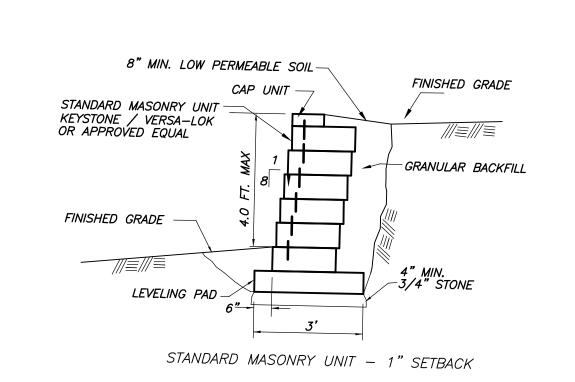
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LOT 4


N 52°52'00" E

FROM A SURVEY DATED 1/6/21,	13.	ALL UTILITIES ARE TO BE INSTALLED UNDERGROUND, AFTER THE BACKFILLING OF TRENCHES FOR THE UTILITIES, THESE AREAS ARE TO BE STABILIZED IN ACCORDANCE WITH THE SPECIFICATIONS NOTED.	24. THE FOLLOWING SITE WORK INSPECTIONS ARE REQUIRED: SILT FENCE (AFTER INSTALLATION)
5 8,462 SQ. FT. 39,914 SQ. FT.	14.	IMMEDIATELY AFTER FINE GRADING, ALL AREAS SHALL BE LIMED, FERTILIZED AND SEEDED.	ALL STORM & ROOF DRAINAGE PIPES (BEFORE BACKFILL) SITE GRADING (BEFORE VEGETATIVE STABILIZATION)
ONMENTAL	15.	DISTURB AS LITTLE AREA AS POSSIBLE DURING EXCAVATION. EXCAVATED MATERIAL IS TO BE DISPOSED OF ON SITE AFTER ALL BUILDING CONSTRUCTION IS COMPLETED, OR DISPOSED OF IN A OFFSITE APPROVED LANDFILL.	FINAL (AFTER VEGETATIVE STABILIZATION)  25. THE ENTIRE SITE IS MAPPED AS PeoB, PENN CHANNERY SILT LOAM SOILS
OPOSED SOIL ONMENTAL	16.	EXISTING UNDERGROUND UTILITY INFORMATION SHOWN HEREON IS APPROXIMATE AND IS NOT GUARANTEED AS TO ACCURACY OR COMPLETENESS. THE CONTRACTOR SHALL VERIFY ALL	26. THE SUBJECT PROPERTY IS LOCATED WITHIN THE NEW VERNON HISTORIC DISTRICT WHICH IS LISTED IN THE NEW JERSEY AND NATIONAL REGISTERS
POTABLE GAS.		INFORMATION PRIOR TO BEGINNING ANY CONSTRUCTION. THE CONTRACTOR SHALL CALL UNDERGROUND UTILITIES 1-800-272-1000 FOR MARKOUT PRIOR TO ANY EXCAVATION.  WHERE EXISTING UNDERGROUND UTILITIES ARE TO BE CROSSED BY PROPOSED CONSTRUCTION,	OF HISTORIC PLACES. THE SUBJECT PROPERTY IS DESIGNATED AS "CONTRIE ON A MAP ENTITLED "NEW VERNON HISTORIC DISTRICT", PER THE HARDING TOWNSHIP MASTER PLAN. NO CHANGES ARE PROPOSED TO THE EXISTING HISTORIC STRUCTURE.
ASSOCIATES,		TEST PITS SHALL BE DUG BY THE CONTRACTOR PRIOR TO CONSTRUCTION TO ACERTAIN EXISTING LOCATIONS, ELEVATIONS, MATERIALS AND SIZES. TEST PIT INFORMATION SHALL BE GIVEN TO THE ENGINEER PRIOR TO CONSTRUCTION TO PERMIT ADJUSTMENTS AS REQUIRED	
PROXIMATE AND IS ACTOR SHALL	17.	TO AVOID CONFLICTS.  ALL KNOWN & PROPOSED EASEMENTS ARE SHOWN ON THIS PLAN.  THE CONTRACTOR WILL ADD ADDITIONAL SOIL EROSION AND SEDIMENT CONTROL MEASURES	
THE CONTRACTOR R LOCAL UTILITY WHERE	18.	AS DIRECTED BY THE TOWNSHIP ENGINEER.  FOR DETAILS RELATED TO THE PROPOSED SEPTIC SYSTEM SEE PLANS PREPARED BY OUR FIRM DATED 10/27/23 FOR CROSS REFERENCING.	
D CONSTRUCTION, TION TO ASCERTAIN FORMATION SHALL	19. 20.	THIS PROPERTY IS SERVED & HEATED BY NATURAL GAS. THE TOWNSHIP CODE REQUIRES THAT SOLID METAL GUTTER COVERS BE	
JUSTMENTS AS  SITE PLAN REVIEW	21.	INSTALLED ON ALL NEW ROOF AREAS THAT DISCHARGE INTO A STORMWATER RECHARGE SYSTEM. SCREENS ARE NOT PERMISSIBLE. ALL DOWNSPOUTS SHALL BE DIRECTED INTO THE ROOF LEADERS CONNECTED TO PROPOSED DRYWELLS OR SPLASHBLOCKS AWAY FROM THE FOUNDATIONS AS INDICATED.	
ING TOWNSHIP		AN AREA AT LEAST 10 FEET WIDE AROUND THE FOUNDATIONS SHALL BE GRADED DOWNWARD AWAY FROM THE PROPOSED FOUNDATIONS.	
TIL ALL  D BACKFILLED W/	23.	THE TOWNSHIP ENGINEER WILL BE NOTIFIED AT LEAST 72 HOURS IN ADVANCE OF THE INSTALLATION OF THE ROOF DRAIN PIPING. $LOT \ \ 3.02$	LIMITS OF DISTURBANCE/
ES. TY CONNECTIONS		PROP. D.I.  GRATE - 338.72 INV 336.22  PROP. D.I.  PROP. D.I.	GRADING BOUNDARY
BLE).	FOUN.	00.122	
APPROXIMATE LOCATION OF ADJACENT CESSPOOL	342	34 LF 12*NODE STATE CONSERVATION AREA	_ I.PIN
100.0, DETACHED  GARAGE		ROP. DRYWELLST HANK "B"  SHOPE  SHOPE	
34 4 4		Solve Sign Sign Sign Sign Sign Sign Sign Sign	
<u>" E                                   </u>	,	2 46.66' SHDE YARD SETBACK STORM	
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STOCKPILE INSTALL INST	LL TOPS FAIL	3412 3412 3412 3412 3412 3412 3412 3412	
PROP. D.I.  GRATE - 346.20 4.7  INV 343.20  PROPOSED	STOPE STOPE	PROR. DRYWELLS 326	Letter of the state of the stat
ACCESS OF DRIVE	12 / K	BANK "A2" LIDS- 344.37/343.70 INV 341.36	
© E.3% SLOPE	SL-5		
FRT. E GF 348.5 2 BE		FRT. ENTRY	
RESIDE SEE G.NOTE #10) UNI AC ON SL NO BASE	ENTAL T #1 AB	AC ON SLAB NO BASEMENT FF- 346.5	₹. O.
X 349.0 FF- 35 6' SIDE YARD S	0.5		
CONC		31-7KEE-CONSERVATION IAREA 111-2-111-111-11-11-11-11-11-11-11-11-11	
BUILDING			
LIMITS OF DI GRADING E		DARY $\Gamma$ $\Gamma$ $\Gamma$	
		(323.42' DEED)  LIMITS OF DISTURBANCE/	
LOT 6		GRADING BOUNDARY	GRAPHIC SCALE  O 10 20 40 80
			( IN FEET ) 1 inch = 20 ft.



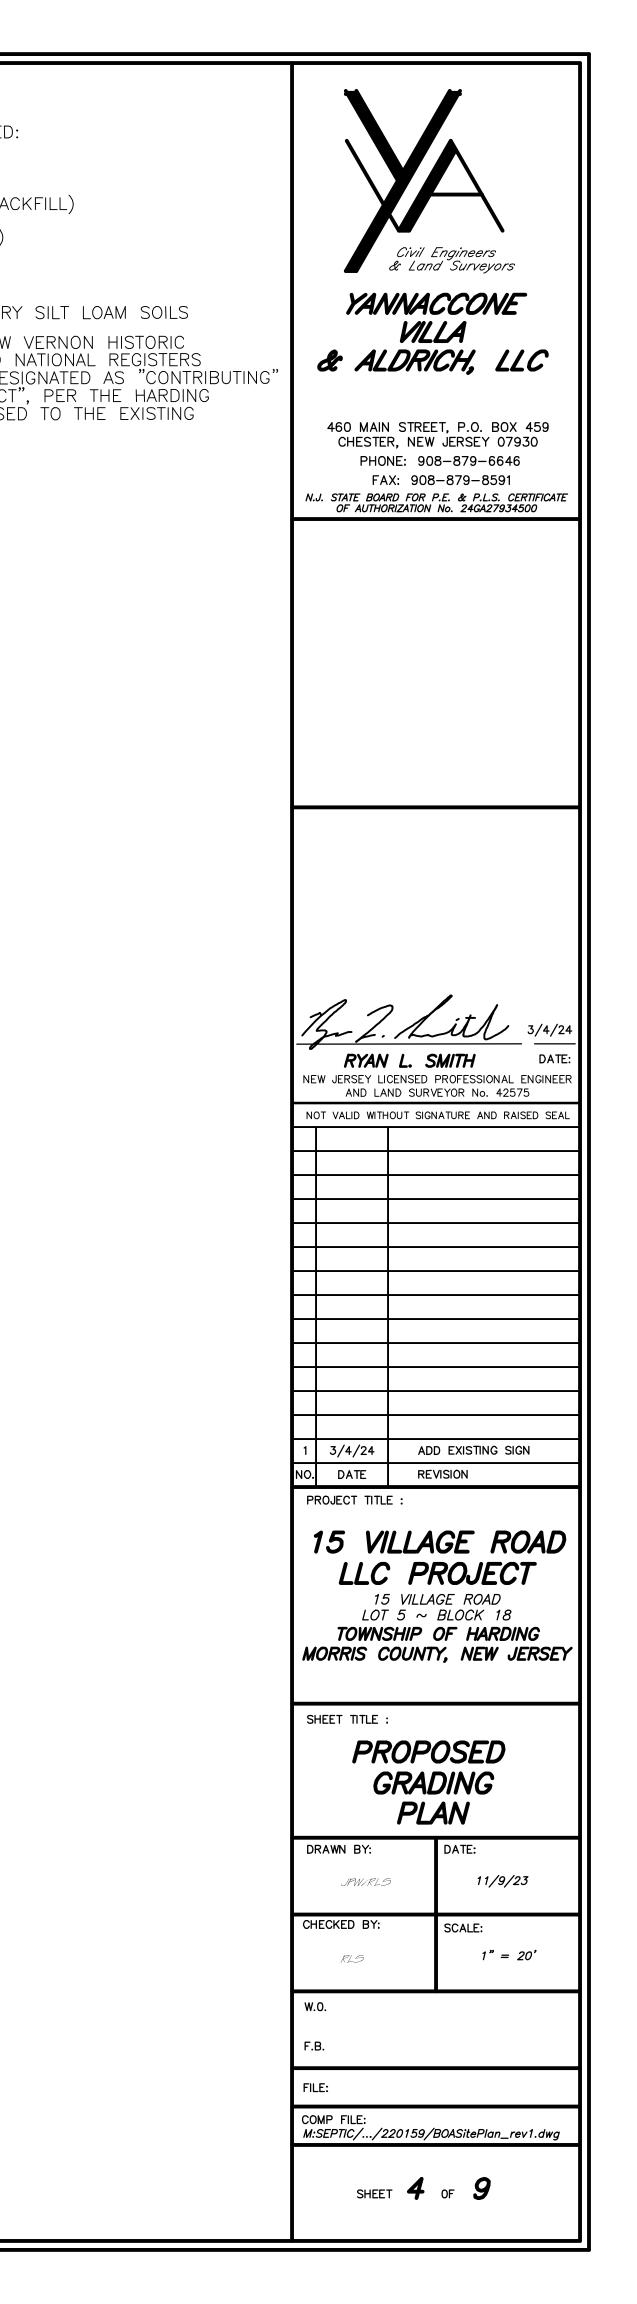


#### TYPICAL MASONRY RETAINING WALL (OR APPROVED EQUAL) NOT TO SCALE

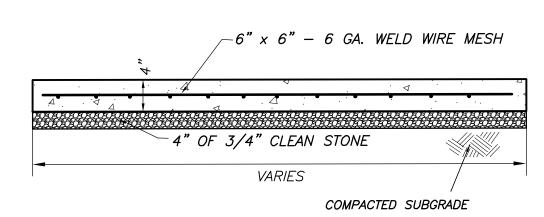


A/C/GEN PADS TO BE 4' X 4' X 4"thick 3,500 PSI CONCRETE CLASS B. TRASH PADS TO BE 8' X 8' X 4"thick 3,500 PSI CONCRETE CLASS B. A/C/GEN & TRASH ENCLOSURE CONCRETE PAD DETAIL

4"x4" WOOD POSTS —

NOT TO SCALE

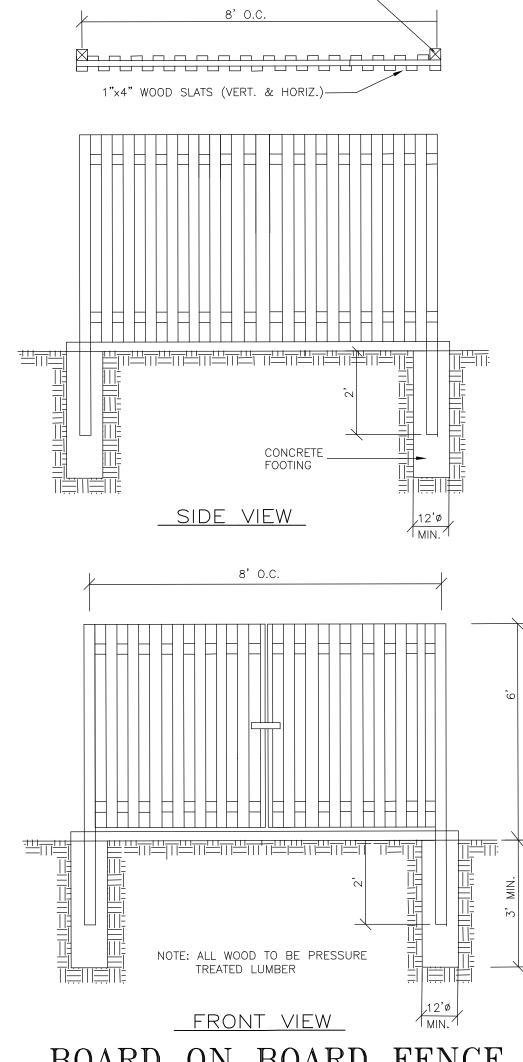


BOARD ON BOARD FENCE TRASH ENCLOSURE DETAIL N.T.S.

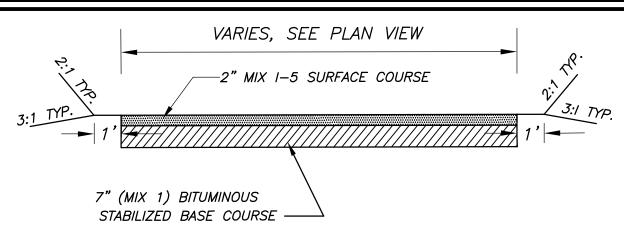

DRIVEWAY PAVEMENT CROSS SECTION

NOT TO SCALE

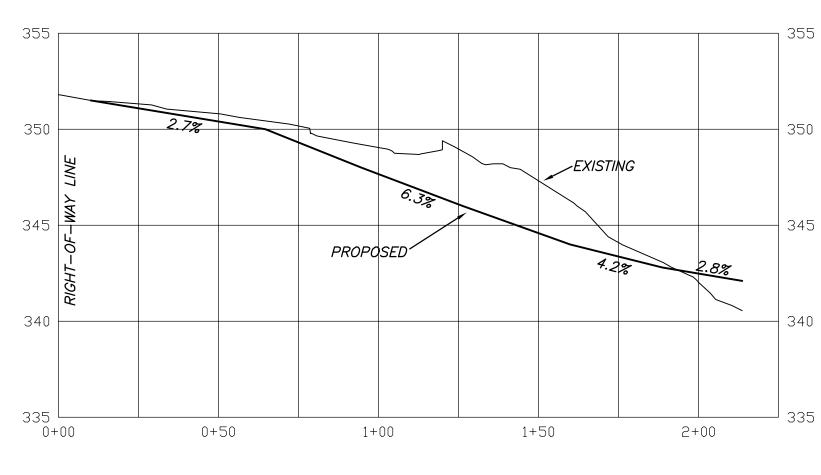

DRIVEWAY CENTERLINE PROFILE


HORIZONTAL SCALE: 1" = 30' VERTICAL SCALE: 1" = 5'


SOIL RESTORATION AREA 3,361 SF

TOTAKL RESTORATION AREA = 15,458 SF


SOIL RESTORATION AREA

SCALE - 1" - 30'

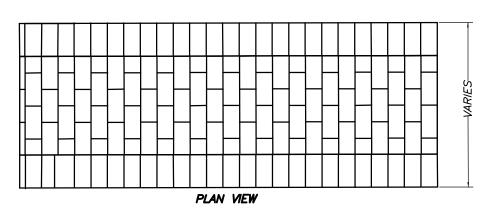


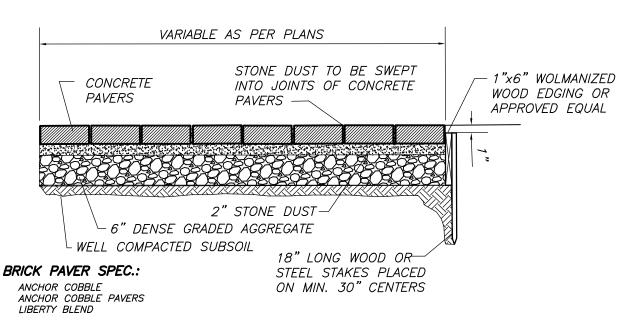



CONCRETE BRICK PAVERS DETAIL

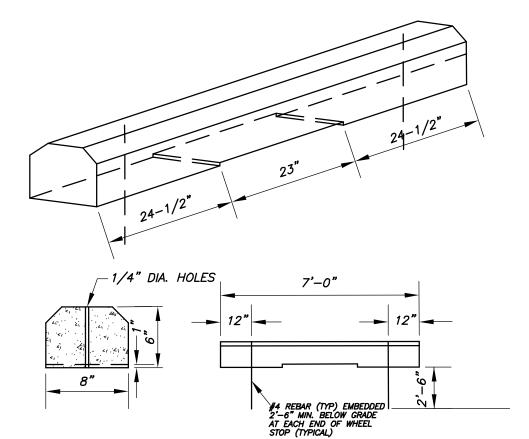


PRECAST CONCRETE WHEEL STOP DETAIL

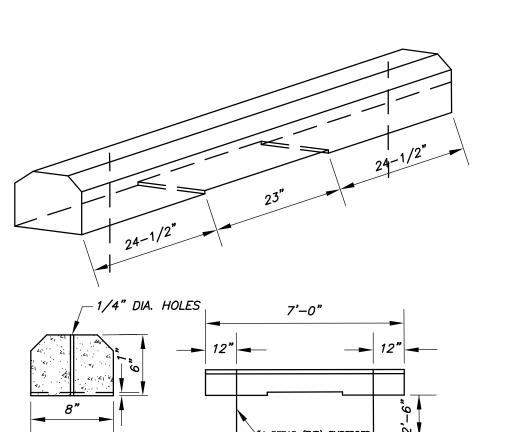

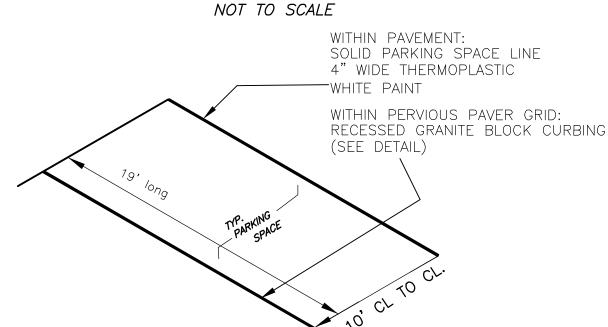

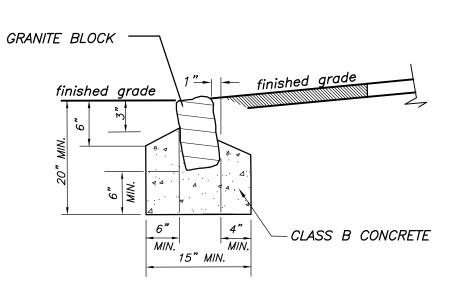

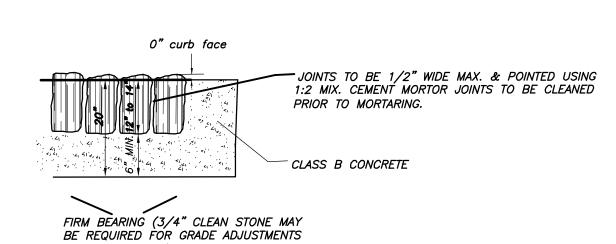

## RECESSED 6" GRANITE BLOCK CURB DETAIL

OR STABILIZATION)

SOIL RESTORATION AREA 12,097 SF

LIMITS OF DISTURBANCE/ GRADING BOUNDARY

39,914 SF (TOTAL)

NOT TO SCALE

NOTE: INSTALL RECESSED GRANITE BLOCK CURBING AT ALL PAVEMENT EDGES

TYP. 'PARKING SPACE' STRIPING DETAIL



#### YANNACCONE VILLA & ALDRICH, LLC

460 MAIN STREET, P.O. BOX 459 CHESTER, NEW JERSEY 07930 PHONE: 908-879-6646 FAX: 908-879-8591 N.J. STATE BOARD FOR P.E. & P.L.S. CERTIFICATE OF AUTHORIZATION No. 24GA27934500

NOT VALID WITHOUT SIGNATURE AND RAISED SEAL

NEW JERSEY LICENSED PROFESSIONAL ENGINEER AND LAND SURVEYOR No. 42575 NOT VALID WITHOUT SIGNATURE AND RAISED SEAL

#### 15 VILLAGE ROAD LLC PROJECT

REVISION

ADD DRIVEWAY PROFILE

15 VILLAGE ROAD LOT 5 ~ BLOCK 18 TOWNSHIP OF HARDING MORRIS COUNTY, NEW JERSEY

SHEET TITLE :

1 3/4/24


DATE PROJECT TITLE :

### CONSTRUCTION DETAIL SHEET #1

DRAWN BY:	DATE:
CF	10/27/23
CHECKED BY:	SCALE:
RL5	AS SHOWN
W.O. <i>220159</i>	
F.B	


COMP FILE: M:SEPTIC/.../220159/BOASitePlan\_rev1.dwg

SHEET 5 OF 9

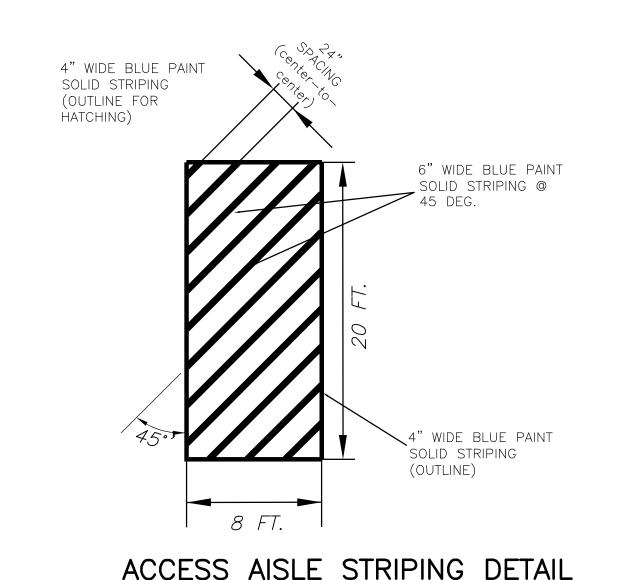


#### ACCESS AISLE STRIPING DETAIL

(ADJACENT TO VAN ACCESSIBLE PARKING SPACE) NOT TO SCALE

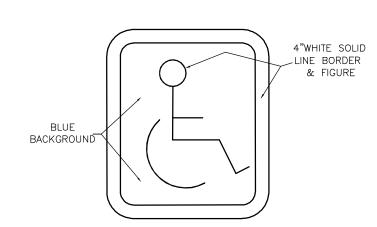

INTERNATIONAL SYMBOL OF ACCESSIBILITY PARKING SPACE WITH BLUE BACKGROUND AND WHITE BORDER (PER MUTCD, V. 2000)

NOT TO SCALE

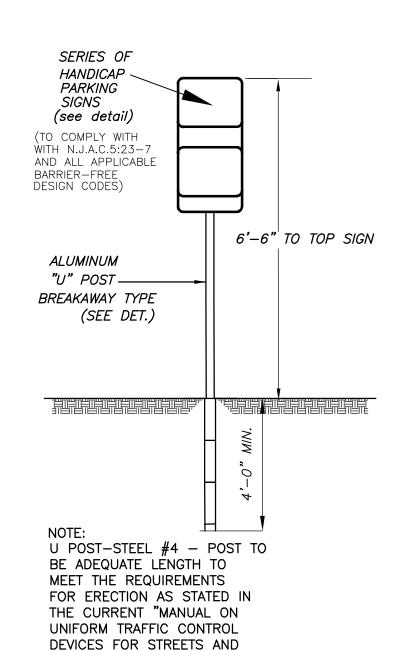

PROPOSE ONE (1) STOP SIGN ON SITE


R1 - 1 750 x 750 MM (0.6 S.M.)

#### HANDICAP PARKING SIGN POST DETAIL

HIGHWAYS" POST AND BRACKETS TO BE GALVINIZED TO CONFORM

WITH CURRENT A.S.T.M. SPECIFICATION A 123.


> NOT TO SCALE (FROM THE "MANUAL OF UNIFORM TRAFFIC CONTROL DEVICES") NOTE: POST TO BE INSTALLED 1 FT. MIN. FROM FACE OF CURBING.

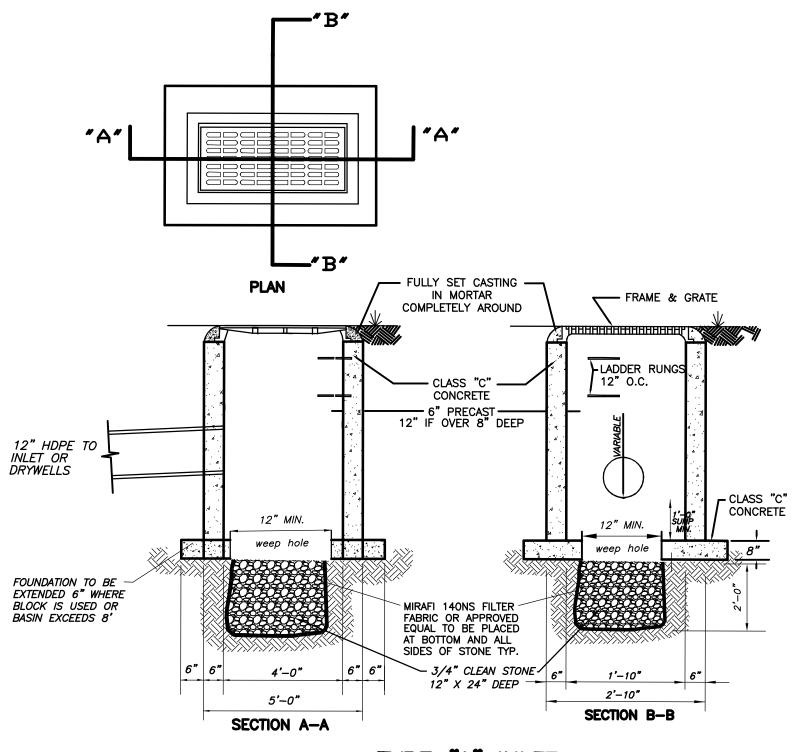

#### TYPE "A" INLET

NOT TO SCALE

- 1. INLET UNIT SHALL BE CONSTRUCTED OF PRECAST CONCRETE
- 2. FRAME AND GRATE TO BE No. 3405 AS MANUFACTURED BY CAMPBELL FOUNDRY OR APPROVED EQUAL.
- 3. PROVIDE 3/4" DIA. ALUMINUM LADDER RUNGS 12" O.C. 4. PRECAST UNIT SHALL BE DESIGNED TO AASHTO H-20 LOADINGS.
- 5. WALLS OVER 8 FT. DEEP SHALL BE 12" THICK.
- 6. ALL PIPES TO BE CUT FLUSH WITH BASIN WALL.

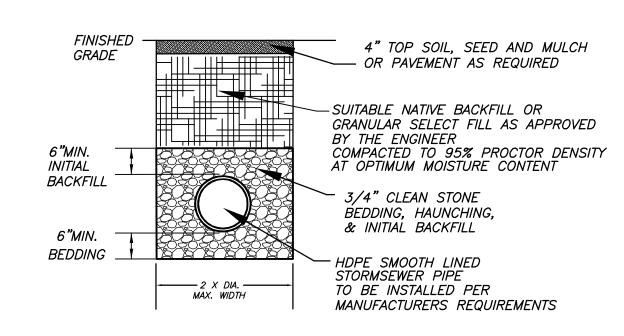

NOTE: ALL HDPE STORMSEWER PIPE SHALL HAVE SMOOTH INTERIOR LINING.

#### HDPE STORMWATER PIPE TRENCH DETAIL NOT TO SCALE

NOTE: POST TO BE INSTALLED 2 FT. MIN.

R1-1 STOP SIGN, ETC. - COLOR & DETAILS TO FOLLOW STANDARDS

PROVIDE BREAKAWAY TYPE
MOUNTING SYSTEM
SEE BREAKAWAY SIGN POST DETAIL

U POST-STEEL #4 - POST TO BE ADEQUATE LENGTH TO

MEET THE REQUIREMENTS FOR ERECTION AS STATED IN

THE CURRENT "MANUAL ON

DEVICES FOR STREETS AND HIGHWAYS" POST AND BRACKETS

TO BE GALVINIZED TO CONFORM

UNIFORM TRAFFIC CONTROL

WITH CURRENT A.S.T.M.

SPECIFICATION A 123.

IN THE CURRENT "STANDARD HIGHWAY SIGNS PUBLICATION" AND THE CURRENT " MANUAL ON


UNIFORM TRAFFIC CONTROL

DEVICES FOR STREETS AND

"STOP" SIGN POST DETAIL

NOT TO SCALE

FROM FACE OF CURBING.

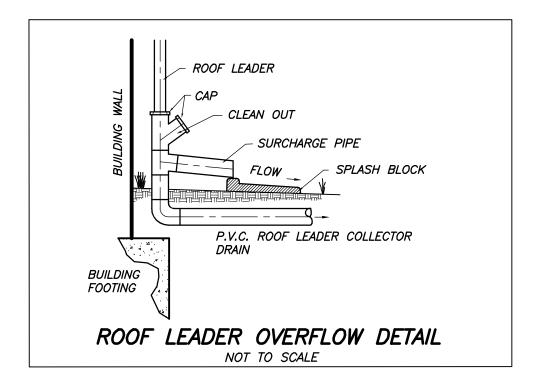



#### EXISTING WOOD SIGN DETAIL

NOT TO SCALE

EXISTING WOOD SIGN
PAINTED BLACK WITH GOLD ACCENTS AND LETTERING



460 MAIN STREET, P.O. BOX 459 CHESTER, NEW JERSEY 07930 PHONE: 908-879-6646 FAX: 908-879-8591 N.J. STATE BOARD FOR P.E. & P.L.S. CERTIFICATE OF AUTHORIZATION No. 24GA27934500

NEW JERSEY LICENSED PROFESSIONAL ENGINEER

AND LAND SURVEYOR No. 42575 NOT VALID WITHOUT SIGNATURE AND RAISED SEA

1 3/4/24 ADD EXISTING SIGN DETAIL NO. DATE REVISION PROJECT TITLE :

#### 15 VILLAGE ROAD LLC PROJECT


15 VILLAGE ROAD LOT 5 ~ BLOCK 18 TOWNSHIP OF HARDING

MORRIS COUNTY, NEW JERSEY SHEET TITLE :

#### CONSTRUCTION DETAIL SHEET #2

DRAWN BY:	DATE:			
CF	11/9/23			
CHECKED BY:	SCALE:			
RL5	AS SHOWN			
W.O.220159				
F.B				
FILE:				
COMP FILE: M:SEPTIC//220159/BOASitePlan_rev1.dwg				

SHEET  $m{6}$  OF

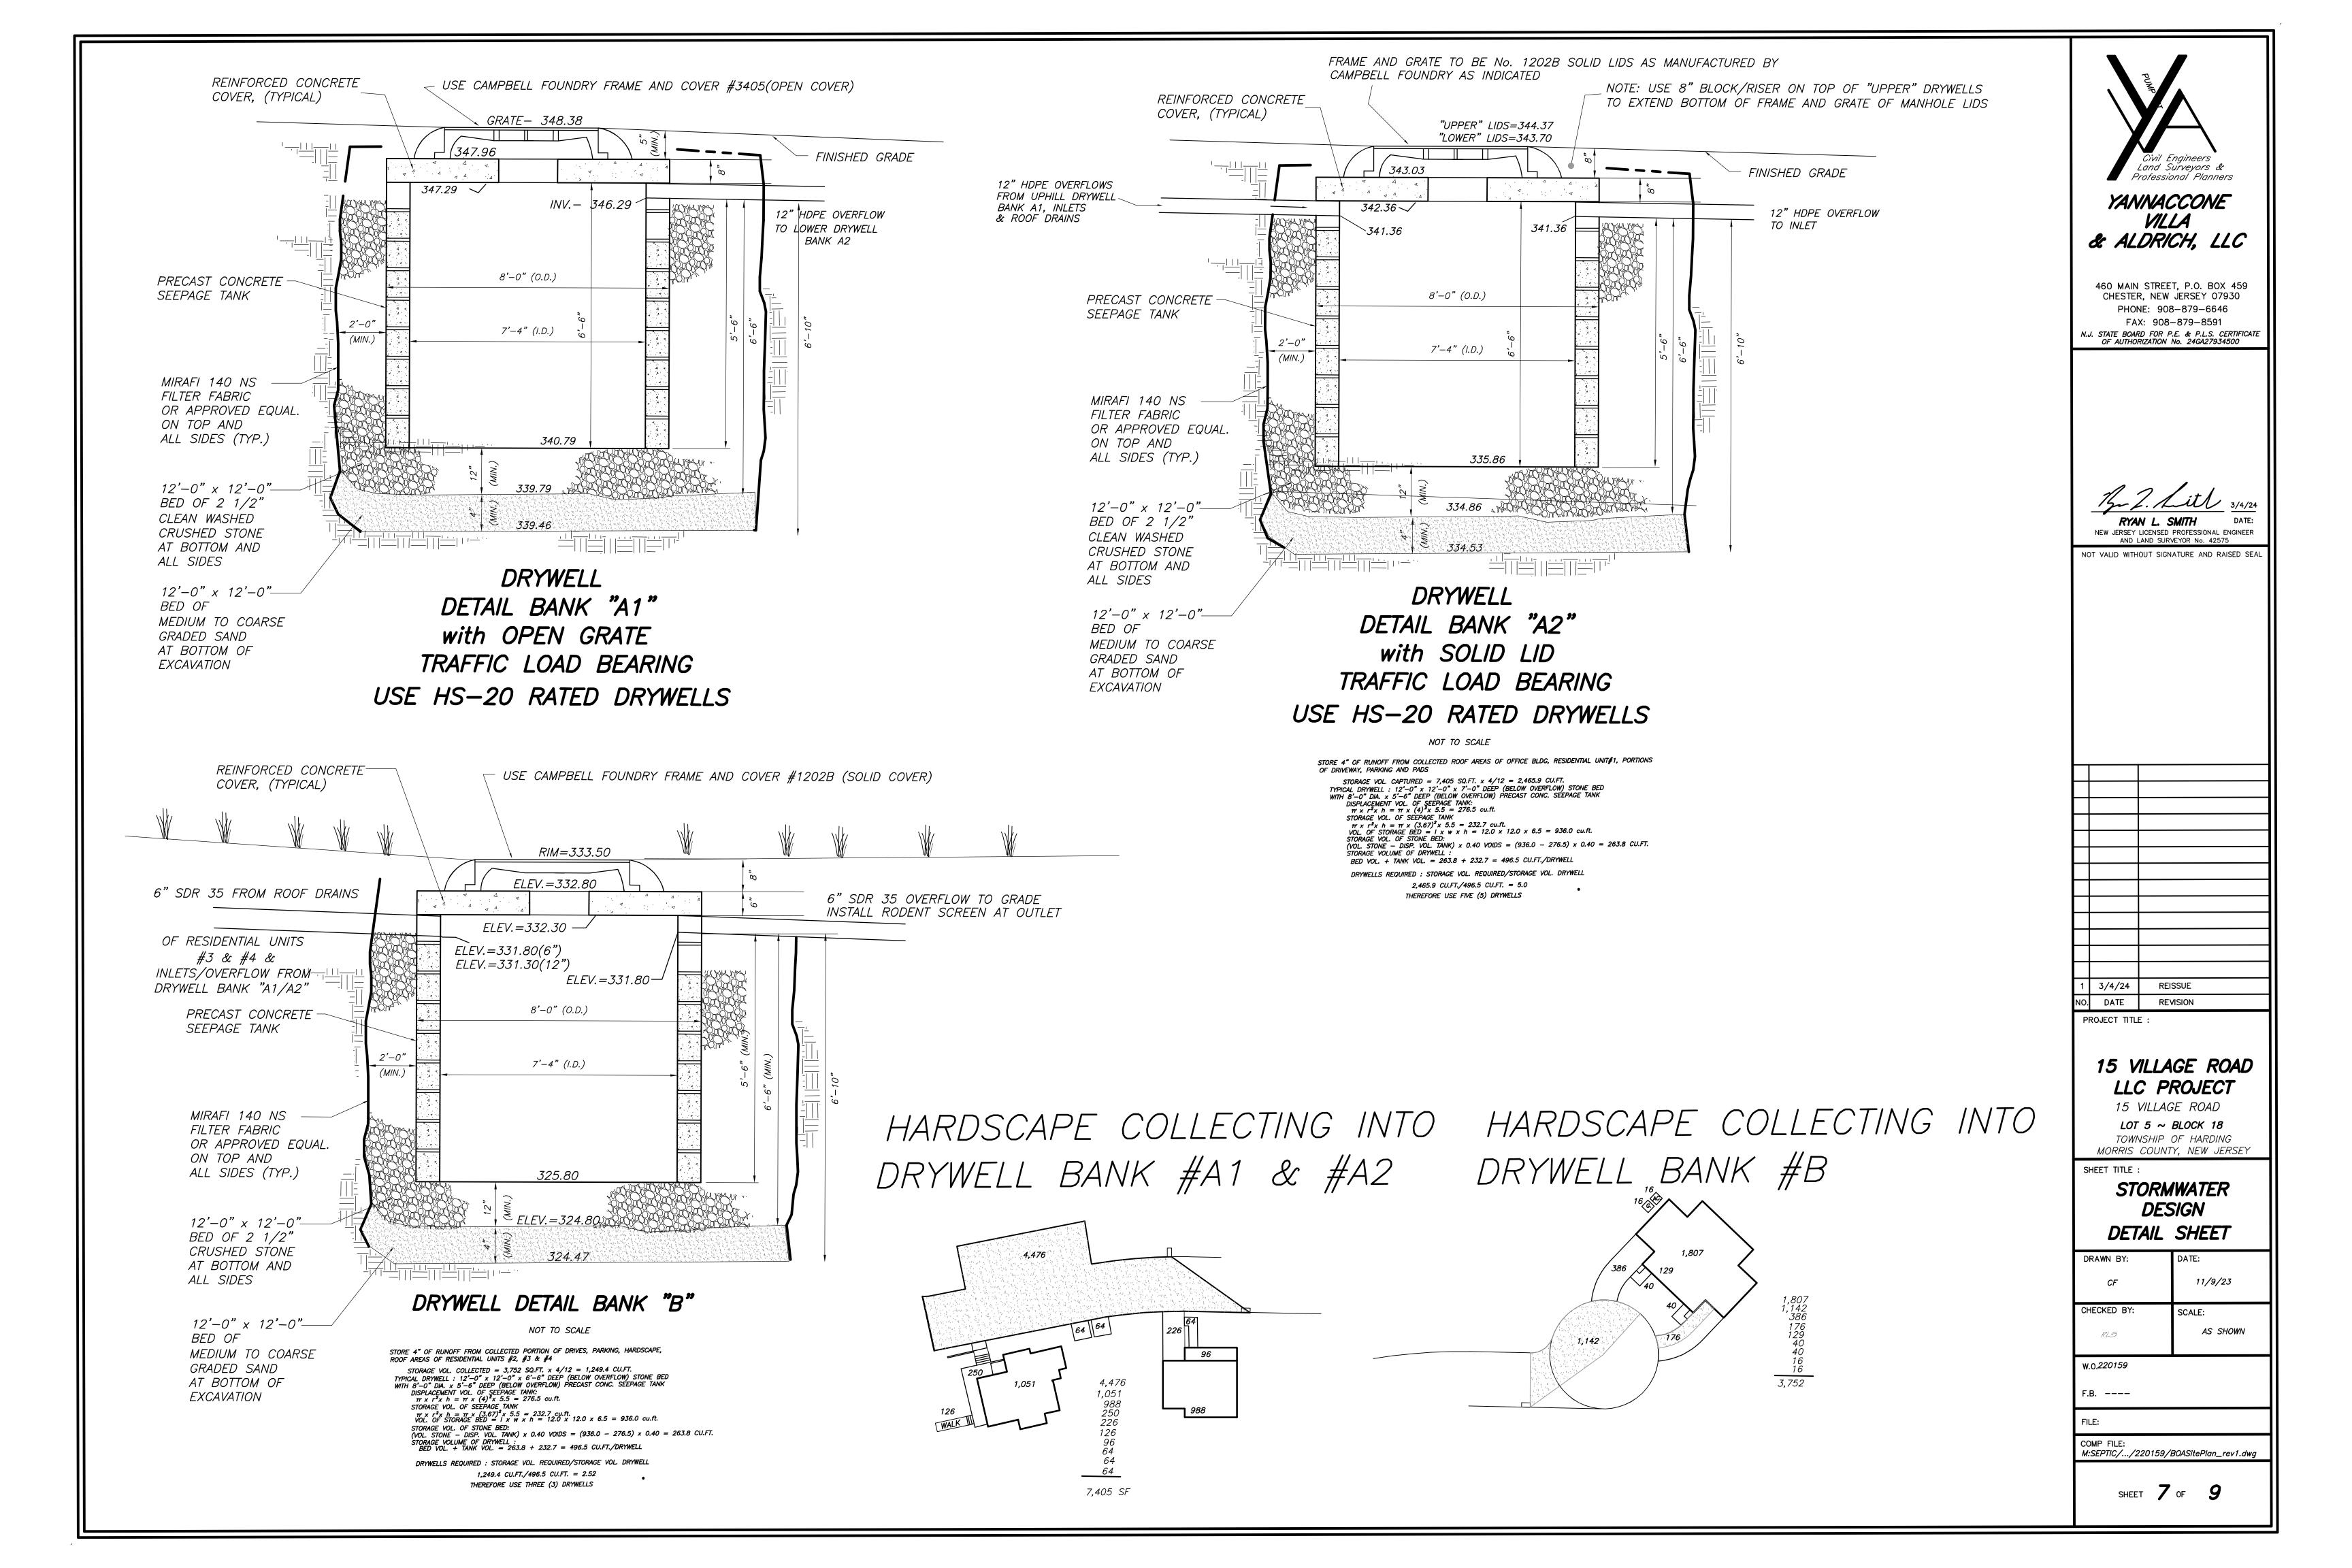

#### SOIL EROSION AND SEDIMENT CONTROL NOTES

- ALL SOIL EROSION AND SEDIMENT CONTROL PRACTICES WILL BE INSTALLED IN ACCORDANCE WITH THE NEW JERSEY STANDARDS FOR SOIL EROSION AND SEDIMENT CONTROL, AND WILL BE PLACE PRIOR TO ANY MAJOR SOIL DISTURBANCE, OR IN THEIR PROPER SEQUENCE AND MAINTAINED UNTIL PERMANENT PROTECTION IS ESTABLISHED.
- ANY DISTURBED AREA THAT WILL BE LEFT EXPOSED FOR MORE THAN THIRTY DAYS AND NOT SUBJECT TO CONSTRUCTION TRAFFIC SHALL IMMEDIATELY RECEIVE A TEMPORARY SEEDING. IF THE SEASON PROHIBITS TEMPORARY SEEDING, THE DISTURBED AREA WILL BE MULCHED WITH SALT HAY OR EQUIVALENT AND BOUND IN ACCORDANCE WITH THE NEW JERSEY STANDARDS (ie. PEG AND TWINE, MULCH NETTING, OR LIQUID MULCH BINDER.)
- PERMANENT VEGETATION IS TO BE ESTABLISHED ON EXPOSED AREAS WITHIN TEN (10) DAYS AFTER FINAL GRADING. MULCH IS TO BE USED FOR PROTECTION UNTIL VEGETATION IS ESTABLISHED.
- 4. IMMEDIATELY FOLLOWING INITIAL DISTURBANCE OR ROUGH GRADING. ALL CRITICAL AREAS (STEEP SLOPES, SANDY SOILS, WET CONDITIONS) SUBJECT TO EROSION WILL RECEIVE A TEMPORARY SEEDING IN ACCORDANCE WITH NOTE 21 BELOW.
- 5. TEMPORARY DIVERSION BERMS ARE TO BE INSTALLED ON ALL CLEARED ROADWAYS AND EASEMENT AREAS. SEE THE SE&SC STANDARDS.
- 6. PERMANENT SEEDING AND STABILIZATION TO BE IN ACCORDANCE WITH THE "STANDARDS FOR PERMANENT VEGETATIVE COVER FOR SOIL STABILIZATION COVER". SPECIFIED RATES AND LOCATIONS SHALL BE ON THE APPROVED SOIL EROSION AND SEDIMENT CONTROL PLAN.
- 7. THE SITE SHALL AT ALL TIMES BE GRADED AND MAINTAINED SO THAT ALL STORM WATER RUNOFF IS DIVERTED TO SOIL EROSION AND SEDIMENT CONTROL FACILITIES.
- 8. ALL SEDIMENTATION STRUCTURES (SILT FENCE, INLET FILTERS, AND SEDIMENT BASINS) WILL BE INSPECTED AND MAINTAINED DAILY.
- 9. STOCKPILES SHALL NOT BE LOCATED WITHIN 50' OF A FLOODPLAIN, SLOPE, DRAINAGE FACILITY, OR ROADWAY. ALL STOCKPILE BASES SHALL HAVE A SILT FENCE PROPERLY ENTRENCHED AT THE TOE
- 10. A STABILIZED CONSTRUCTION ACCESS WILL BE INSTALLED, WHENEVER AN EARTHEN ROAD INTERSECTS WITH A PAVED ROAD. SEE THE STABILIZED CONSTRUCTION ACCESS DETAIL AND CHART FOR DIMENSIONS.
- 11. ALL NEW ROADWAYS WILL BE TREATED WITH SUITABLE SUBBASE UPON ESTABLISHMENT OF FINAL GRADE ELEVATIONS.
- 12. PAVED ROADWAYS MUST BE KEPT CLEAN AT ALL TIMES.
- 13. BEFORE DISCHARGE POINTS BECOME OPERATIONAL, ALL STORM DRAINAGE OUTLETS WILL BE STABILIZED AS REQUIRED.
- 14. ALL DEWATERING OPERATIONS MUST DISCHARGED DIRECTLY INTO A SEDIMENT FILTER AREA. THE SEDIMENT FILTER SHOULD BE COMPOSED OF A FABRIC OR APPROVED MATERIAL. SEE THE SE&SC STANDARDS.
- 15. ALL SEDIMENT BASINS WILL BE CLEANED WHEN THE CAPACITY HAS BEEN REDUCED BY 50%. A CLEAN-OUT ELEVATION WILL BE IDENTIFIED ON THE PLAN AND A MARKER INSTALLED ON THE SITE.
- 16. DURING AND AFTER CONSTRUCTION, THE APPLICANT WILL BE RESPONSIBLE FOR THE MAINTENANCE AND UPKEEP OF THE DRAINAGE STRUCTURES, VEGETATIVE COVER, AND ANY OTHER MEASURES DEEMED APPROPRIATE BY THE DISTRICT. SAID RESPONSIBILITY WILL PRECLUDE WHEN COMPLETED WORK IS APPROVED BY THE TOWNSHIP ENGINEER.
- 17. ALL TREES OUTSIDE THE DISTURBANCE LIMIT INDICATED ON THE SUBJECT PLAN OR THOSE TREES WITHIN THE DISTURBANCE AREA WHICH ARE DESIGNATED TO REMAIN AFTER CONSTRUCTION ARE TO BE PROTECTED WITH TREE PROTECTION DEVICES. SEE THE TREE PROTECTION DETAIL
- 18. HARDING TOWNSHIP MAY REQUEST ADDITIONAL MEASURES TO MINIMIZE ON SITE OR OFF SITE EROSION PROBLEMS DURING CONSTRUCTION.
- 19. THE HARDING TOWNSHIP ENGINEER MUST BE NOTIFIED, IN WRITING, AT LEAST 72 HOURS PRIOR TO ANY LAND DISTURBANCE AND A PRE-CONSTRUCTION MEETING HELD.
- 20. THE HARDING TOWNSHIP ENGINEER MUST BE NOTIFIED AT LEAST 72 HOURS PRIOR TO INSTALLATION OF DRYWELLS OR ROOF DRAIN PIPING THE CONTRACTOR WILL ADD ADDITIONAL SOIL EROSION & SEDIMENT CONTROL MEASURES AS DIRECTED BY THE TOWNSHIP ENGINEER.
- 21. APPROPRIATE SAFETY MEASURES SHALL BE TAKEN ABOVE RETAINING WALLS AS DIRECTED BY THE TOWNSHIP ENGINEER.

#### 22. TOPSOIL STOCKPILE PROTECTION

- a. APPLY GROUND LIMESTONE AT A RATE OF 90 LBS. PER 1000 SF. APPLY FERTILIZER (10-20-10) AT A RATE OF 11 LBS/1000 S.F. APPLY PERENNIAL RYEGRASS AT A RATE OF 1 LB/1000 S.F. AND
- d. MULCH STOCKPILE WITH STRAW OR HAY AT AT RATE OF 90 LBS./1000 S.F. APPLY A LIQUID MULCH BINDER OR TACK TO STRAW OR HAY MULCH. PROPERLY ENTRENCH A SILT FENCE AT THE BOTTOM OF THE STOCKPILE
- TEMPORARY STABILIZATION SPECIFICATIONS
- APPLY GROUND LIMESTONE AT A RATE OF 90 LBS. PER 1000 SF. b. APPLY FERTILIZER (10-20-10) AT A RATE OF 11 LBS/1000 S.F. APPLY PERENNIAL RYEGRASS AT A RATE OF 1 LB/1000 S.F. AND
- ANNUAL RYEGRASS AT 1 LB. PER 1000 S.F. MULCH STOCKPILE WITH STRAW OR HAY AT AT RATE OF 90 LBS./1000 S.F. APPLY A LIQUID MULCH BINDER OR TACK TO STRAW OR HAY MÚLCH.
- PERMANENT STABILIZATION SPECIFICATIONS
- APPLY TOPSOIL TO A DEPTH OF 5 INCHES (UNSETTLED) b. APPLY GROUND LIMESTONE AT A RATE OF 90 LBS. PER 1000 SF. AND WORK FOUR INCHES INTO SOIL.
- APPLY FERTILIZER (10-20-10) AT A RATE OF 11 LBS/1000 S.F. d. APPLY HARD FESCUE SEED AT 2.7 LBS./1000 S.F. AND CREEPING RED FESCUE SEED AT 0.7 LBS./1000 S.F. AND PERENNIAL RYEGRASS SEED AT
- e. MULCH STOCKPILE WITH STRAW OR HAY AT AT RATE OF 90 LBS./1000 S.F. APPLY A LIQUID MULCH BINDER OR TACK TO STRAW OR HAY MULCH.

#### DUST CONTROL NOTES

- THE FOLLOWING METHODS SHOULD BE CONSIDERED FOR CONTROLLING DUST:
- MULCH SEE STANDARD OF STABILIZATION WITH MULCHES ONLY (SE&SC IN NJ, #5, JULY 1999) .
- VEGETATIVE COVER SEE STANDARD FOR : TEMPORARY VEGETATIVE COVER (SE&SC IN NJ, #7, JULY 1999), AND PERMANENT VEGETATIVE COVER FOR SOIL STABILIZATION (SE&SC IN NJ, #4, JULY 1999) AND PERMANENT STABILIZATION WITH SOD (SE&SC IN NJ, #6, JULY 1999).
- 3. SPRAY-ON ADHESIVES ON MINERAL SOILS (NOT EFFECTIVE ON MUCK SOILS). KEEP TRAFFIC OFF THESE AREAS. SEE SE&SC IN NJ, #16, JULY 1999, FOR DUST CONTROL ADHESIVES.
- TILLAGE TO ROUGHEN SURFACE AND BRING CLODS TO THE SURFACE. BEGIN PLOWING ON WINDWARD SIDE OF SITE BEFORE SOIL BLOWING STARTS. CHISEL-TYPE PLOWS SPACED ABOUT 12 INCHES APART, AND SPRING—TOOTHED HARROWS ARE EXAMPLES OF EQUIPMENT WHICH MAY PRODUCE THE DESIRED EFFECT.
- 5. SPRINKLING SITE IS SPRINKLED UNTIL THE SURFACE IS WET.
- BARRIERS SOLID BOARD FENCES, SNOW FENCES, BURLAP FENCES, CRATE WALLS, BALES OF HAY AND SIMILAR MATERIAL CAN BE USED TO CONTROL AIR CURRENTS AND SOIL BLOWING.
- CALCIUM CHLORIDE SHALL BE IN THE FORM OF LOOSE, DRY GRANULES OR FLAKES FINE ENOUGH TO FEED THROUGH COMMONLY USED SPREADERS AT A RATE THAT WILL KEEP SURFACE MOIST BUT NOT CAUSE POLLUTION OR PLANT DAMAGE. IF USED ON STEEPER SLOPES, THEN USE OTHER PRACTICES TO PREVENT WASHING INTO STREAMS, OR ACCUMULATION AROUND PLANTS.

#### THE FOLLOWING SITE WORK INSPECTIONS ARE REQUIRED BY HARDING TOWNSHIP :

- 1. CONSTRUCTION & SILT FENCE AFTER INSTALLATION
- 2. DRYWELL EXCAVATION SUBSOILS (BEFORE SAND, STONE OR CHAMBER INSTALLATION)
- DRYWELL SYSTEM(AFTER SAND, STONE AND CHAMBER INSTALLATION, BEFORE BACKFILL) 4. ROOF DRAIN PIPES, SEWER LINE AND OTHER DRAINAGE PIPES(BEFORE BACKFILL)
- 5. SEPTIC SYSTEM INSTALLATION

VEGETATIVE COVER IS ESTABLISHED.

TO BE PROTECTED

CATALOG NUMBER - SILTO2XO4

ACF ENVIRONMENTAL-2831 CARDWELL ROAD-RICHMOND, VIRGINIA 23234-(800) 448-3636

DRAINAGE INLET AND

CATCH BASIN SILT FILTERING SYSTEM

TREE PROTECTION DETAIL

7. FINAL (AFTER STABILIZATION)


6. SITE GRADING (BEFORE VEGETATIVE STABILIZATION)

#### SEQUENCE OF CONSTRUCTION

- NOTIFY MUNICIPAL ENGINEER, HARDING TOWNSHIP CONSTRUCTION AND HEALTH DEPARTMENT 72 HOURS PRIOR TO THE START OF CONSTRUCTION.
- 2. INSTALL ANTI-TRACKING PAD/WHEEL CLEANING BLANKET AT ACCESS POINT. 3. INSTALL SILT FENCE ALONG LINES AS INDICATED. 2 days
- 4. TREE REMOVAL, CLEARING AND STRIPPING OF DISTURBED AREAS. 2 weeks STOCKPILE TOPSOIL. ROUGH GRADE SITE.
- 5. CONSTRUCTION OF BUILDINGS w/ SITE IMPROVEMENTS. 9 months 6. INSTALL STORMWATER MANAGEMENT MEASURES & SEPTIC SYSTEM. 1 month INSTALL INLET PROTECTION. INSTALL UNDERGROUND UTILITIES.
- 1 week PRIOR TO THE APPLICATION OF TOPSOIL. MULCH AND SEED.

7 FINE GRADING. SCARIFY SUBGRADE SOILS TO A DEPTH OF 6"

2 days 8. INSTALL FINAL PAVEMENT COURSE. 9. REMOVE SILT FENCE & SESC MEASURES WHEN PERMANENT

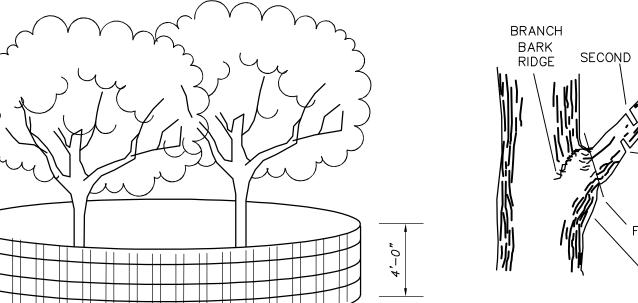

**INSTALLATION:** 

INSTALLATION:

BY COVERING WITH SOIL.

REBAR THROUGH POCKETS.

2. REMOVE CATCH BASIN COVER GRATE.

5. REMOVE STRAPS FROM LIFTING BARS

BARS AND LIFTING WITH AVAILABLE EQUIPMENT.

6. INSERT A LIFTING BAR THROUGH BOTH EMPTYING STRAPS

7. LIFT WITH AVAILABLE EQUIPMENT WITH EMPTYING STRAPS

SNOW FENCE TO BE INSTALLED AT DRIP LINE OF TREE CLUSTER

\_\_\_\_ 2 EACH DUMP STRAPS

. INSTALL SILT SACK IN CATCH BASIN, MAKING SURE EMPTYING STRAPS ARE LAID FLAT OUTSIDE OF BASIN AND HELD IN

2. HOLD DOWN REMOVAL FLAP POCKETS AND EMPTYING STRAPS

REMOVE SOIL COVERING REMOVAL FLAP POCKETS AND INSERT

3. REMOVE SILT SACK FROM CATCH BASIN BY ATTACHING TO BOTH

4. MOVE FILED SILT SACK TO DUMPING AREA AND SET ON GROUND

CURB OPENING FILTER

EXPANSION RESTRAINT


(1/4" NYLON ROPE, 2" FLAT WASHERS)

# SECOND CUT FINAL CUT BRANCH COLLAR

2 days

## TREE LIMB REMOVAL


#### ENTIRE LENGTH OF CONSTRUCTION ACCESS -12' WIDE x 6" THICK ASTM C-33 No. 2 CRUSHED STONE (2 1/2"-1 1/2") WELL COMPACTED MATERIAL - FILTER FABRIC MIRAFI 140NS OR APPROVED EQUAL EDGE OF EXISTING PAVEMENT SECTION VIEW

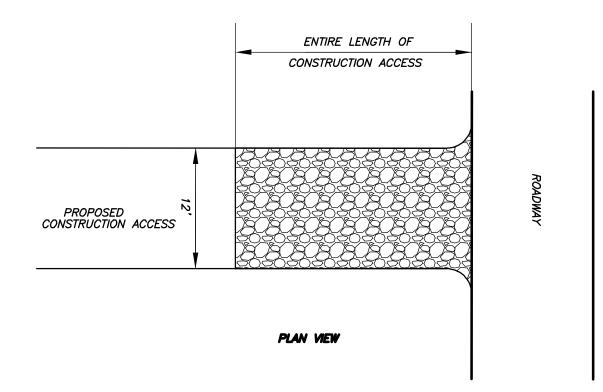

## STABILIZED CONSTRUCTION ACCESS

LENGTHS OF CONSTRUCTION EXITS ON SLOPING ROADBEDS

PERCENT SLOPE OF ROADWAY	LENGTH OF STONE REQUIRED		
	COARSE GRAINED SOILS	FINE GRAINED SOILS	
0 TO 2%	50 FT.	100 FT.	
2 TO 5%	100 FT.	200 FT.	
>5%	ENTIRE SURFACE STABILIZ	TED WITH FABC BASE COARSE	

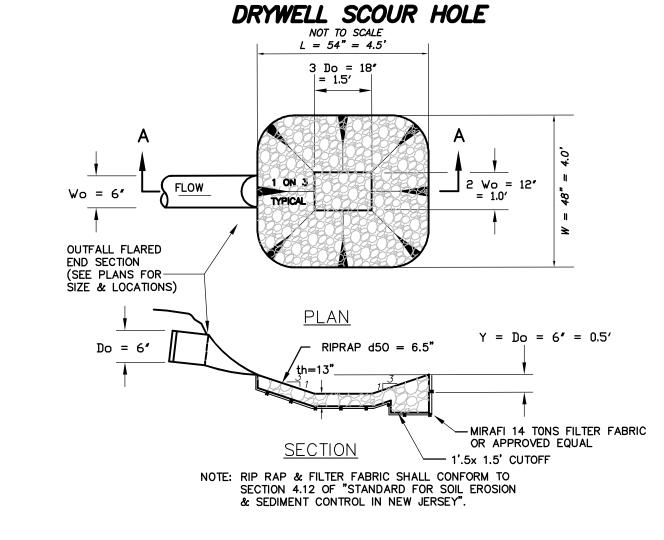

#### DRYWELL SCOUR HOLE CALCULATIONS

COMBINED AREAS DIRECTED TO DRYWELL BANKS = 11,157 SQ. FT.

C = 0.99, i = 5.8, A = 11,157 SF = 0.256 ACRES Q10 = 0.99 \* 5.8 \* 0.256 = 1.47 CFS

Q100=C\*i\*A C = 0.99, i = 8.0, A = 11,157 SF = 0.256 ACRES Q100 = 0.99 \* 8.0 \* 0.256 = 2.03 CFS


QFULL (MANNING'S FORMULA) =  $A * 1.486/n * R^2/3 * S^1/2$ A=0.196 SF, n=0.01 (PVC), P=1.571, R=A/P=0.125, S=0.08 FT/FT QFULL = 0.196 \* 1.486/0.01 \* (0.125)^2/3 \* (0.08) ^1/2 = 2.06 CFS

 $d50 = (0.0082 / Tw) q^1.33$ where Tw = 0.2 Do = 0.2(0.5') = 0.1 FT.

where q = QFULL/Do = 2.06 cfs / 0.5 ft. = 4.12 cfs/ftso,  $d50 = (0.0082 / 0.1) 4.12^{1.33}$ 

= 0.54 FT. ~ 6.5 INCHES.


th = 2(d50) with filter fabric th = 13 INCHES w/ FILTER FABRIC

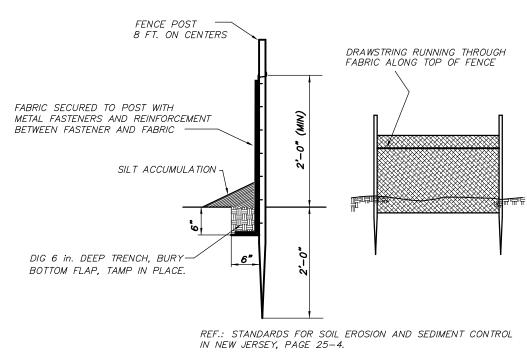


#### REQUIREMENTS FOR SILT FENCE:

- (1.) FENCE POSTS SHALL BE SPACED 8 FEET CENTER-TO-CENTER OR CLOSER. THEY SHALL EXTEND AT LEAST 2 FEET INTO THE GROUND AND EXTEND AT LEAST 2 FEET ABOVE GROUND. POSTS SHALL BE CONSTRUCTED OF HARDWOOD WITH A MINIMUM DIAMETER THICKNESS OF 1-1/2 INCHES. (2.) A METAL FENCE WITH 6 INCH OR SMALLER OPENINGS AND AT LEAST 2 FEET HIGH MAY BE UTILIZED. IT MUST BE FASTENED TO THE FENCE POSTS TO PROVIDE REINFORCEMENT AND SUPPORT TO THE GEOTEXTILE FABRIC
- WHERE SPACE FOR OTHER PRACTICES IS LIMITED AND HEAVY SEDIMENT LOADING IS EXPECTED. (3.) A GEOTEXTILE FABRIC, RECOMMENDED FOR SUCH USE BY THE MANUFACTURER, SHALL BE BURIED AT LEAST 6 INCHES DEEP IN THE GROUND. THE FABRIC SHALL EXTEND AT LEAST 2 FEET ABOVE THE GROUND. THE FABRIC MUST BE SECURELY FASTENED TO THE POSTS USING A SYSTEM CONSISTING OF METAL FASTENERS (NAILS OR STAPLES) AND A HIGH STRENGTH REINFORCEMENT MATERIAL (NYLON WEBBING, GROMMETS. WASHERS, ETC.). PLACED BETWEEN THE FASTENER AND THE GEOTEXTILE FABRIC. THE FASTENING SYSTEM SHALL RESIST TEARING AWAY FROM THE POST. THE FABRIC SHALL INCORPORATE A DRAWSTRING IN THE TOP PORTION OF THE FENCE.

SILT FENCE DETAIL NOT TO SCALE

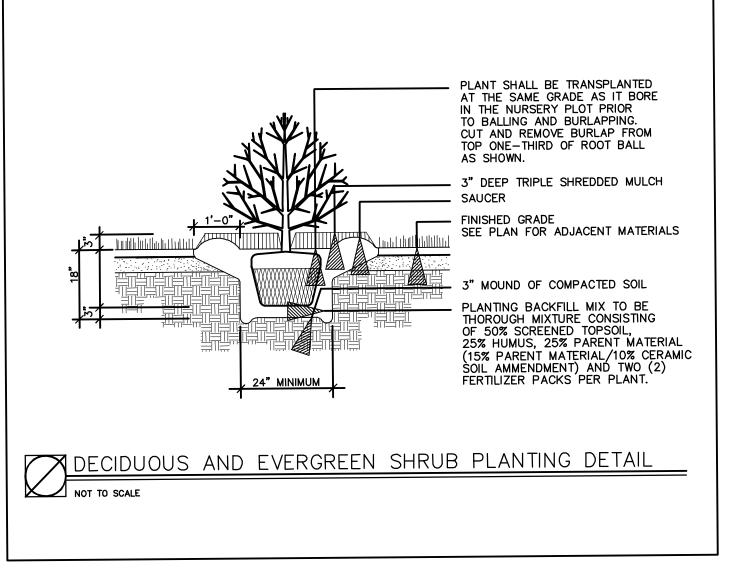

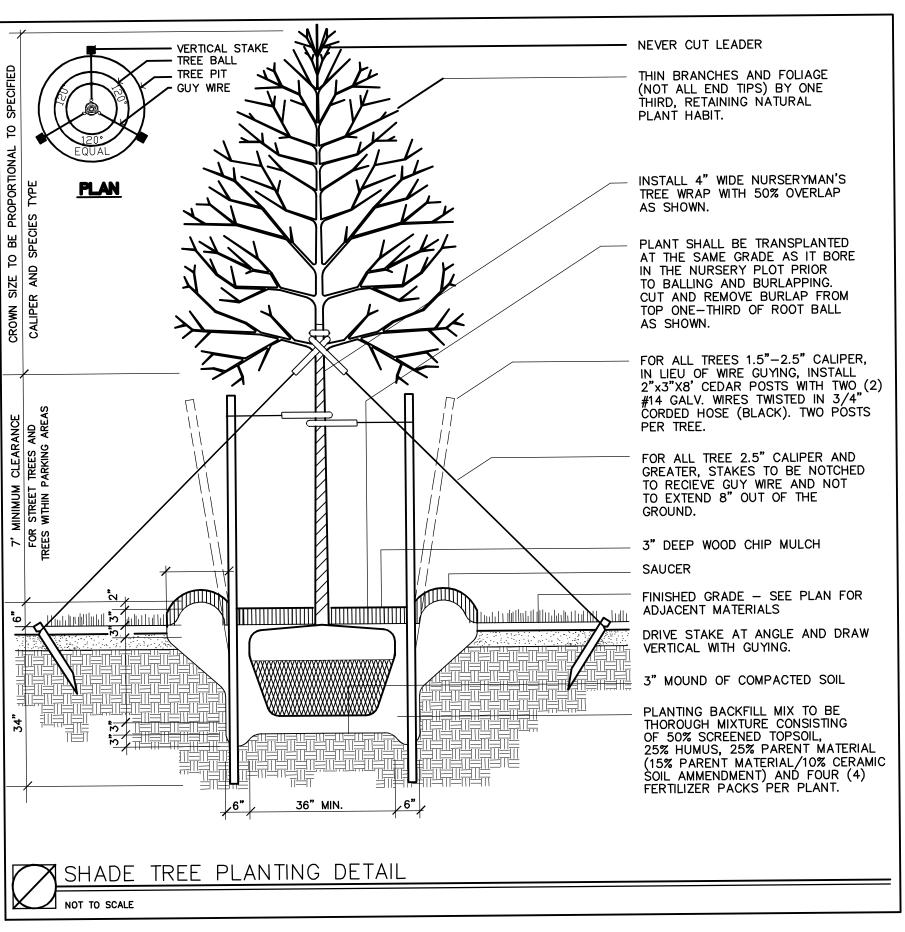



YANNACCONE VILLA & ALDRICH, LLC

460 MAIN STREET, P.O. BOX 459 CHESTER, NEW JERSEY 07930 PHONE: 908-879-6646 FAX: 908-879-8591 N.J. STATE BOARD FOR P.E. & P.L.S. CERTIFICATE OF AUTHORIZATION No. 24GA27934500

NEW JERSEY LICENSED PROFESSIONAL ENGINEER AND LAND SURVEYOR No. 42575 NOT VALID WITHOUT SIGNATURE AND RAISED SEA

1 3/4/24 REISSUE DATE REVISION PROJECT TITLE

#### 15 VILLAGE ROAD LLC PROJECT

15 VILLAGE ROAD LOT 5 ~ BLOCK 18 TOWNSHIP OF HARDING MORRIS COUNTY, NEW JERSEY

SHEET TITLE:


SOIL EROSION & SEDIMENT CONTROL DETAIL SHEET

DRAWN BY: 11/9/23 CHECKED BY: SCALE: AS SHOWN RLS

W.O. 220159 F.B. ----

M:SEPTIC/.../220159/BOASitePlan\_rev1.dwg

SHEET 8 OF 9

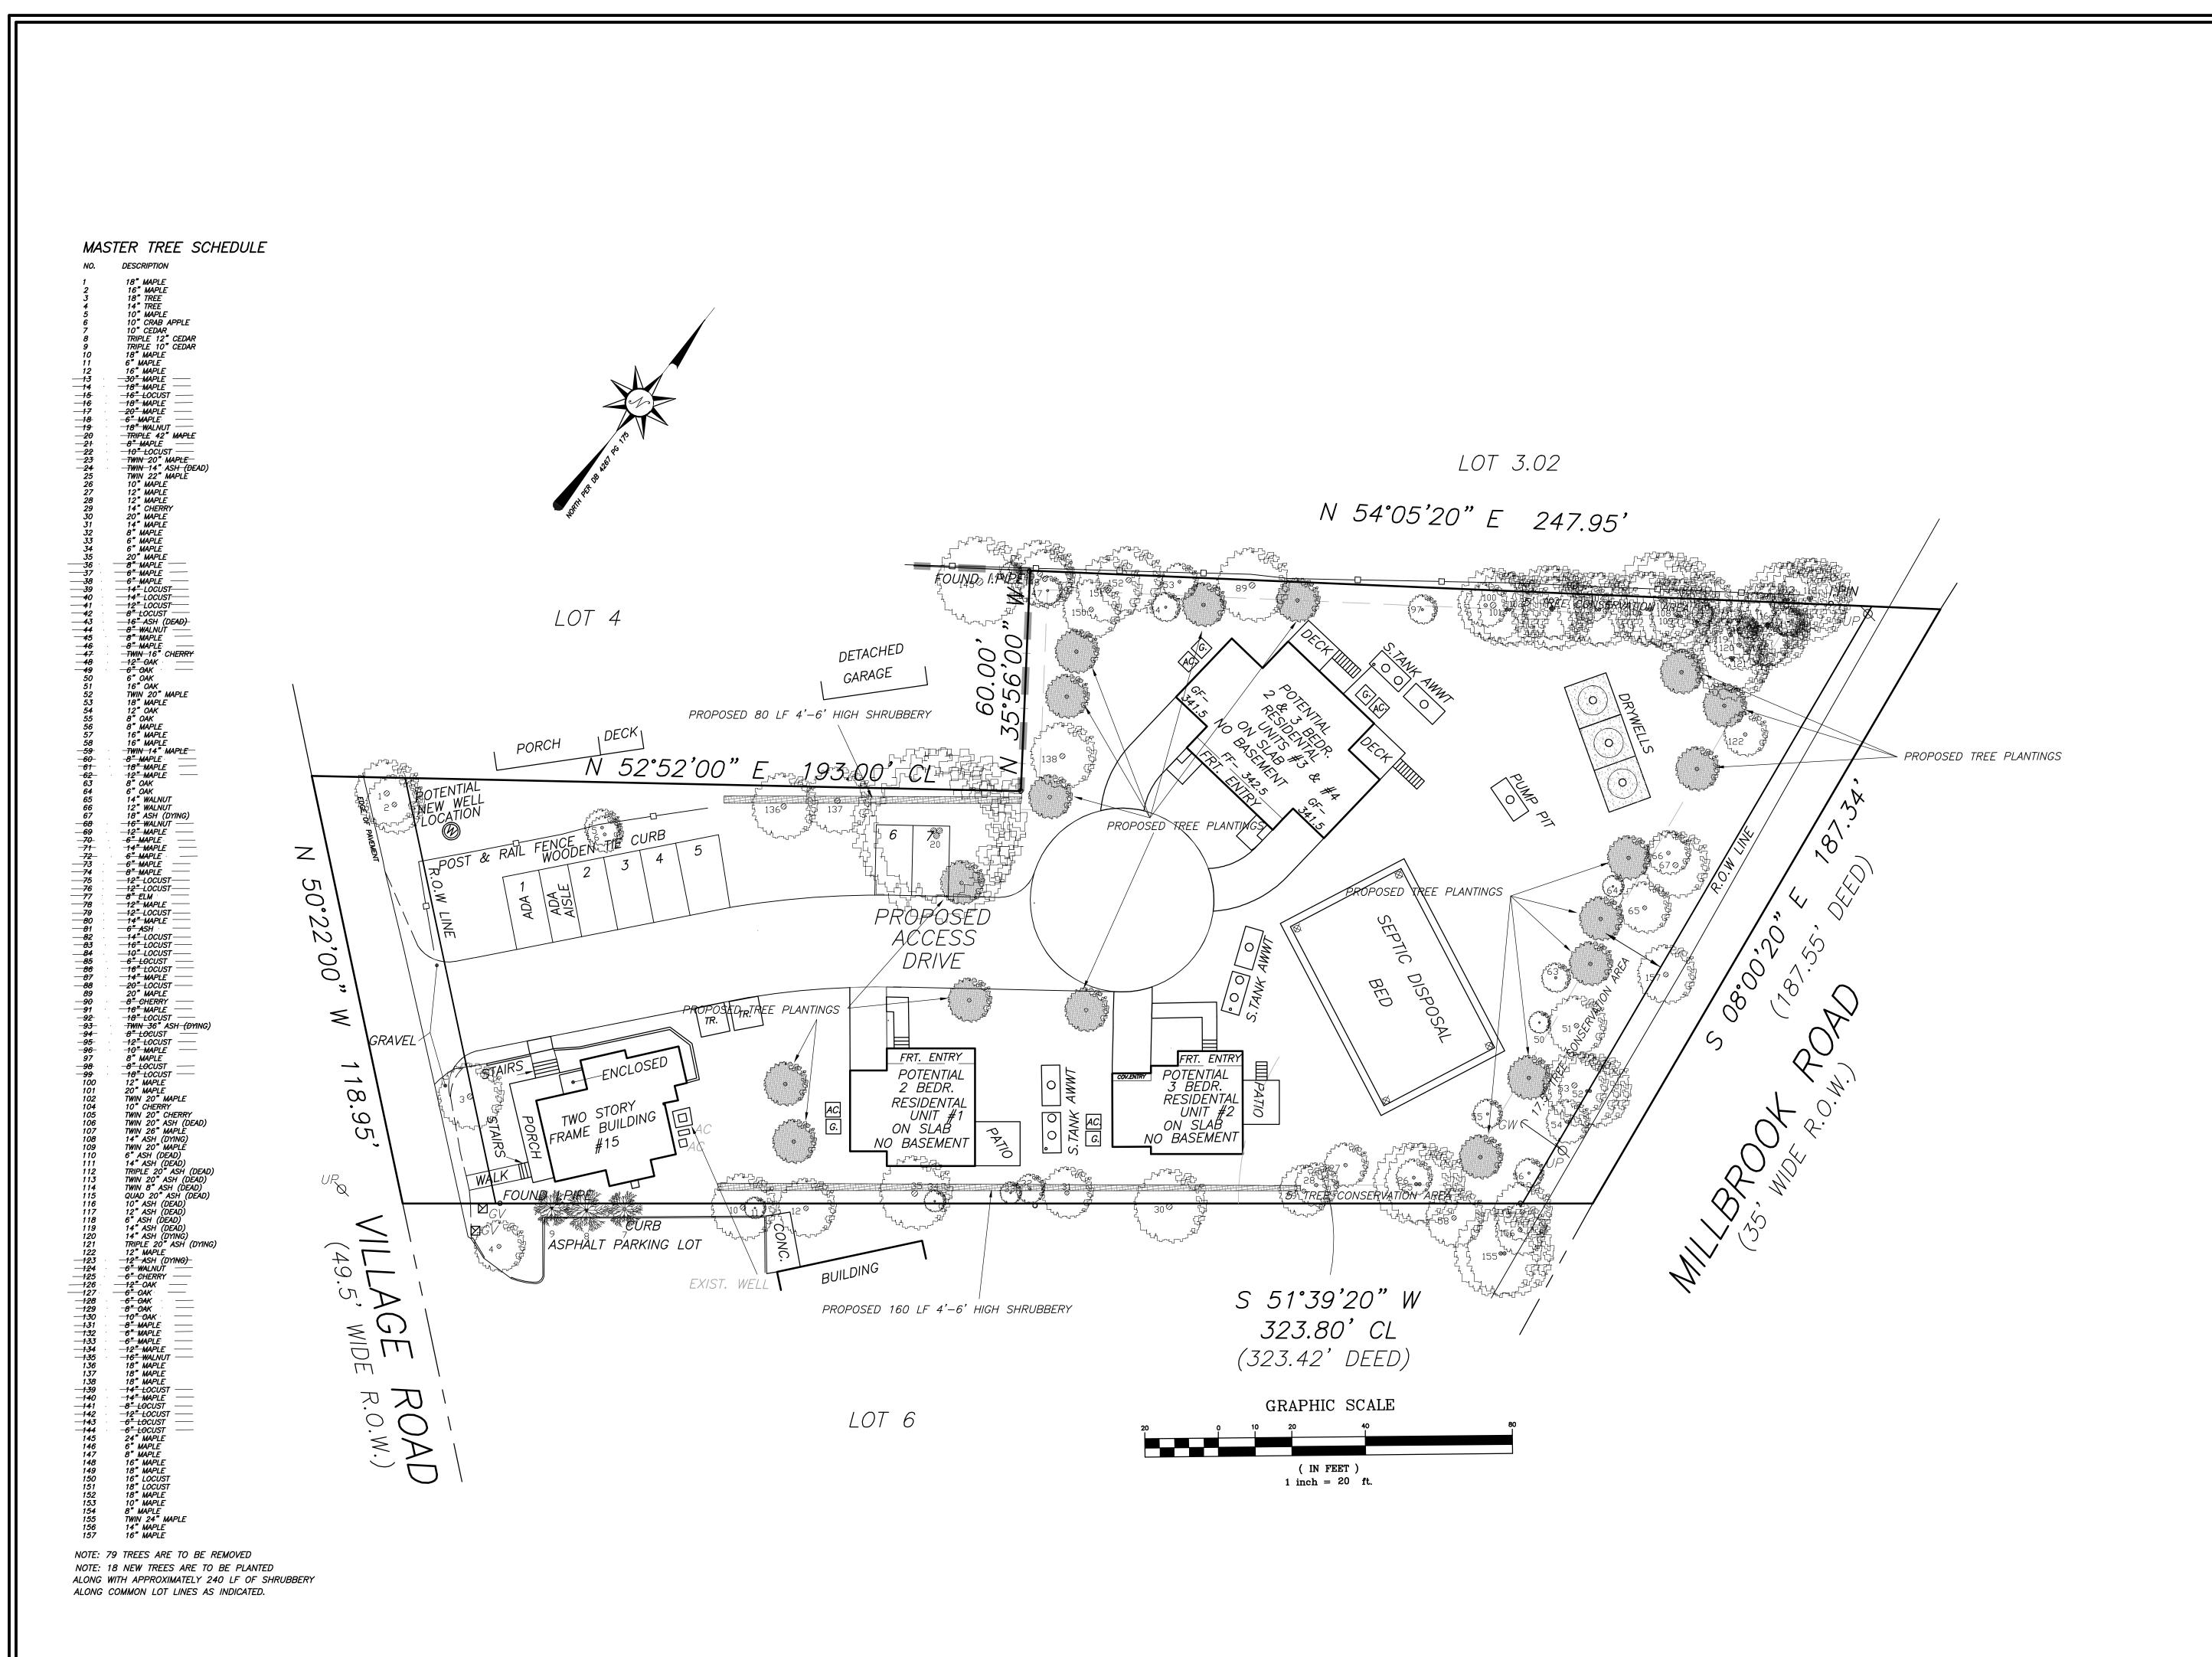



460 MAIN STREET, P.O. BOX 459
CHESTER, NEW JERSEY 07930
PHONE: 908-879-6646
FAX: 908-879-8591

N.J. STATE BOARD FOR P.E. & P.L.S. CERTIFICATE
OF AUTHORIZATION No. 24GA27934500

VILLA & ALDRICH, LLC

RYAN L. SMITH

NEW JERSEY LICENSED PROFESSIONAL ENGINEER
AND LAND SURVEYOR No. 42575

NOT VALID WITHOUT SIGNATURE AND RAISED SEAL

3/4/24 SHEET ADDED TO SET

DATE REVISION

PROJECT TITLE:

## 15 VILLAGE ROAD LLC PROJECT 15 VILLAGE ROAD LOT 5 ~ BLOCK 18

15 VILLAGE ROAD LOT 5 ~ BLOCK 18 TOWNSHIP OF HARDING MORRIS COUNTY, NEW JERSEY

SHEET TITLE :

#### LANDSCAPE PLAN

DRAWN BY:	DATE:	
JPW/RL5	3/4/24	
CHECKED BY:	SCALE:	
RL5	1" = 20'	
W.O. F.B.		
		FILE:
COMP FILE: M:SEPTIC//220159/BOASitePlan_rev1.dwg		

SHEET  $m{g}$  of  $m{g}$